LANDMARKS PRESERES IN COMMISSION ELECTRONIC APPROVALION 95/01/2023 - LP

Brooklyn, NY 11201

PROPERTY OWNER: Ju Young Oh & Michael Kang

T. 646.915.2399

40 Schermerhorn Street Brooklyn, NY 11201

Michael Kang, owner, mskpublic@yahoo.com Juyoung Oh, owner, juyoungoh@gmail.com

40 SCHERMERHORN STREET

ARCHITECT: KLC ARCHITECTS, PC 180 Maiden Lane, Suite#8A New York, NY 10038

T. 212.947.0880, Contact: Jay Cho, RA jc@klcapc.com

RENOVATION OF EXISTING 4 STORY MULTI-FAMILY DWELLING

TENANT PROTECTION NOTES:

PROPERTY INFORMATION

ADDRESS: BLOCK/ LOT#:

CB#

ZONING

ZONING MAP

LANDMARK:

TA RESTRICTED:

CONSTRUCTION

SPECIAL DISTRICT:

HPD MULTIPLE HOUSING:

ENVIRONMENTAL RESTRIC.: NO

1. PER 2014 §28-104.8.4, TENANT PROTECTION PLAN CONSTRUCTION DOCUMENTS FOR ALTERATIONS OF BUILDINGS IN WHICH ANY DWELLING UNIT WILL BE OCCUPIED DURING CONSTRUCTION SHALL INCLUDE A

THERE SHALL BE NO OCCUPIED DWELLING DURING ENTIRE DURATION OF RENOVATION

40 SCHERMERHORN ST

R6. C6-2A (R8A EQUIVALENT)

DB (DOWNTOWN BROOKLYN), LH-1(LIMITED HEIGHT DISTRICT)

II-B (REFER TO TABLE 3-4 FOR REQUIRED FIRE-RESISTANCE RATINGS)

270/46

3002693

2. CONSTRUCTION WORK SHALL NOT BLOCK HALLWAYS OR MEANS OF EGRESS. SHALL BE CONFINED TO NORMAL WORKING HOURS 8:00AM TO 5:00PM. MONDAY THROUGH FRIDAY EXCEPT LEGAL HOLIDAYS.

STRUCTURAL ENGINEER: LB ENGINEERING, PC

325 West 38th Street, Suite 704 New York, NY 10018 T. 201.983.3344

Contact: James Gwangjin Oh, PE james.benatg@gmail.com

6	4/13/23	REV. PER LPC COMMENTS
5	7/15/22	DOB FILING
4	4/15/22	LPC FILING REV1
3	2/5/22	LPC FILING
2	2/2/22	OWNER REVIEW
1	12/15/21	OWNER REVIEW

NO: DATE: ISSUE:

1. THIS APPLICATION IS FILED FOR BUILDING RENOVATION OF EXISTING 4 STORY, MULTI-FAMILY DWELLING

DOB B-SCAN JOB # STICKER DOB NOW #B00679292-I1

07/05/2022 Issued for Construction

SEAL & SIGNATURE :



COVER SHEET / NOTES

T.100.00



SYMBOL / KEY LEGEND **ELEVATION TAG KEY NOTE TAG** DRAWING NUMBER SHEET NUMBER WINDOW TAG **ENLARGED PLAN NUMBER** DOOR NUMBER REFERENCE SHEET NUMBER FRAME NUMBER DIRECTION OF VIEW REFERENCE SECTION NUMBER ROOM NAME ROOM NAME / ROOM NUMBER REFERENCE SHEET NUMBER PARTITION TYPE DESIGNATION DETAIL OR SECTION NUMBER REFERENCE SHEET NUMBER **BULLETIN TAG REVISION BUBBLE** DRAWING OR DETAIL NAME / NUMBER # SCALE: MATERIAL TRANSITION **EXISTING COLUMN DESIGNATION** NORTH ARROW FIN. FLR. 0'-0" AFF LEVEL LINE, CONTROL POINT OR DATUM FLOOR DRAIN **EXISTING BUILDING STRUCTURE** ROOF DRAIN NEW WALL/ PARTITION **NEW DOOR** FIRE RATED PARTITION - 2HR

SCHERMERHORN STREET

(E)IRON FENCE

EXISTING 15 STORY HIGH COMMERICAL BUILDING

EXISTING

BUILDING

3 STORY+BASEMENT

BRICK RESIDENTIAL

(N)WOODEN FENCE -

4 STORY+CELLAR

PROPOSED BLDG ⊊EXT. @BASEMENT ÇIST,2ND,3RD,4TH FL

> PROPOSED DECK 18'6"X 7'0"

> > REAR YARD (LANDSCAPED)

-(E)BRICK FENCE

YARD 40 STATE ST. EXISTING 3 STORY RESIDENTIAL

LANDMARKS PRESERVATION COMMISSION

ELECTRONIC APPROVAL - 05/01/2023 - LP

BRICK RESIDENTIAL

94'-3" TO CORNER



PROJ.

PTD.

PWDR.

PROJECT

PAINTED

POWDER ROOM

WATER CLOSET

WATER HEATER

WOOD

WITHOUT

W.H.

W/O

FLOOR

F.O.S

FLOOR DRAIN

FLUORESCENT

FACE OF FINISH

FACE OF STEEL/ STUD

GENERAL NOTES

- 1. ALL WORK SHALL COMPLY WITH THE INDICATED NYC BUILDING CODES AS WELL AS ALL APPLICABLE CODES. RULES AND REGULATIONS AS WELL AS ANY AND ALL REGULATORY AGENCIES INCLUDING BUT NOT LIMITED TO OSHA, DOH, ADA, ETC. GENERAL NOTES SHALL APPLY TO ALL DRAWINGS.
- 2. THE GENERAL CONTRACTOR SHALL VERIFY ALL JOB CONDITIONS, DIMENSIONS AND DETAILS PRIOR TO CONSTRUCTION, AND AS ANTICIPATED OR INFERRED PRIOR TO COMMENCEMENT OF WORK. ARCHITECT SHALL BE NOTIFIED OF ANY DISCREPANCIES OR OMISSIONS WHICH WOULD INTERFERE WITH THE SATISFACTORY COMPLETION OF THE WORK, PRIOR TO THE START OF ANY AND ALL WORK.
- 3. ALL WORK, WHETHER SHOWN OR IMPLIED, UNLESS SPECIFICALLY QUESTIONED, SHALL BE CONSIDERED FULLY UNDERSTOOD IN ALL RESPECTS BY THE GENERAL CONTRACTOR, AND HE WILL BE RESPONSIBLE FOR ANY MISINTERPRETATIONS OR CONSEQUENCES THEREOF FOR ALL WORK ON ALL DRAWINGS.
- 4. THE GENERAL CONTRACTOR SHALL BE RESPONSIBLE FOR ACQUIRING OF THE BUILDING PERMIT, PAYMENT OF ALL APPLICABLE FEES AND SCHEDULING ALL REQUIRED PROGRESS/ FINAL INSPECTIONS AND OBTAINING THE JOB SIGN-OFF AT THE END OF PROJECT.
- 5. THE GENERAL CONTRACTOR SHALL SCHEDULE ALL WORK TO CONFORM TO THE GENERAL CONSTRUCTION SCHEDULE AND SHALL COODINATE ENTIRE WORK WITH OTHER TRADES IN THE REQUIRED SEQUENTIAL INSTALLATION SCHEDULE.
- 6. ALL MANUFACTURED ARTICLES, MATERIAL AND EQUIPMENT SHALL BE SUPPLIED, INSTALLED, CONNECTED, ERECTED, USED, CLEANED AND CONDITIONED AS DIRECTED BY THE MANUFACTURERS UNLESS OTHERWISE SPECIFIED ON THE CONTRACT DOCUMENTS.
- 7. THE CONTRACTOR SHALL COMPLY IN ALL RESPECTS WITH THE RULES AND REGULATIONS OF THE BUILDING MANAGEMENT. IT SHALL BE THE CONTRACTOR'S RESPONSIBILITY TO OBTAIN SUCH REGULATIONS FROM THE BUILDING OWNER. IN THE RESULT OF CONFLICT BETWEEN BUILDING REGULATIONS AND OTHER CONTRACT DOCUMENTS, ARCHITECT SHALL BE CONSULTED PRIOR TO PROCEEDING.
- 8. DRAWINGS ARE NOT TO BE SCALED; WRITTEN DIMENSIONS GOVERN.
- 9. THE CONTRACTOR SHALL WARRANTEE THE WORK TO BE FREE FROM DEFECTIVE MATERIALS AND WORKMANSHIP FOR A PERIOD OF ONE (1) YEAR AFTER OCCUPANCY OF THE PREMISES UNLESS OTHERWISE

NYC DOB APPROVAL NOTES

THIS PLAN IS APPROVED ONLY FOR THE WORK INDICATED ON THE APPLICATION SPECIFICATION SHEET. ALL OTHER MATTERS SHOWN ARE NOT TO BE RELIED UPON OR TO BE CONSIDERED AS EITHER BEING APPROVED OR IN ACCORDANCE WITH APPLICABLE CODES.

d. INSTALLATION OF NEW DECK, PATIO @REAR YARD

DRAWING SCHEDULE

SUMMARY OF WORKSCOPE

INSTALL NEW LIGHT FIXTURE

2. BUILDING EXTERIOR WORK SHALL INCLUDE

a. CHANGES OF EXISTING 4 FAMILY DWELLING TO 2 FAMILY DWELLING

ADJUST BASEMENT & CELLAR FLOOR LEVEL PER PLAN

UPGRADE EXISTING HVAC SYSTEM WITH NEW

TO CLOSE TO THE ORIGINAL BUILDING DESIGN

c. INSTALLATION OF NEW EXTERIOR WINDOWS @ REAR OF THE BUILDING.

c. RENOVATE INTERIOR OF BUILDING @ ALL FLOORS BY

b. HORIZONTAL FLOOR ENLARGEMENT AT BASEMENT, 1ST, 2ND, 3RD, 4TH FLOOR @REAR YARD

INSTALLATION OF NEW INTERIOR PARTITIONS AND FINISHES PER DRAWINGS.

a. INSTALLATION OF NEW CORNICE @ FRONT FACADE & OTHER HISTORICAL ARCHITECTURAL DETAILS

INSTALLATION OF NEW INTERIOR DOORS, HARDWARE & FIXTURES

UPGRADE EXISTING PLUMBING FIXTURE & EQUIPMENTS WITH NEW

INSTALLATION OF NEW INTERIOR STAIRS THROUGHOUT ENTIRE FLOORS

RESIDENTIAL BUILDING, WORK INCLUDES

b. LPC FILING

TITLE COVERSHEET Z-100 **ZONING ANALYSIS** Z-101 CODE COMPLIANCE

DEMOLITION PLANS DM-101 DEMOLITION PLANS A-200 FLOOR PLANS FLOOR PLANS A-201

A-202 FLOOR PLANS REFLECTED CEILING PLANS A-301 REFLECTED CEILING PLANS

A-500 BUILDING FRONT ELEVATION & DETAILS A-501 **BUILDING REAR ELEVATION & DETAILS** BUILDING SECTION A-600

ENGINEERING: REFER TO ENGINEERING PLANS

*STRUCTURAL APPLICATION SHALL BE FILED SEPARATELY. *MECHANICAL, PLUMBING APPLICATION SHALL BE FILED SEPARATELY.

NEW PLOOF OPENING **BASEMENT FOURTH FLOOR CELLAR** FIRST FL.~THIRD FL. (GARDEN LEVEL) FLOOR AREA // PROPOSED EXTENSION AREA

SHERMERHORN STREET


BROOKLYN HEIGHT LANDMARD DISTRICT MAP

PROPERTY LOCATED ON

ZONNING MAP (16C)

R6 / C6-2A ZONE

SCALE: N.T.S.

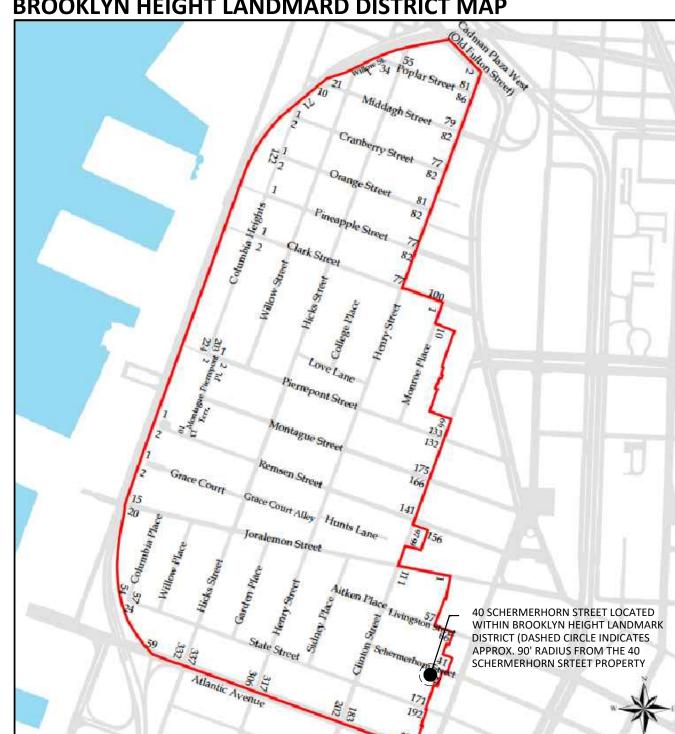

BUILDING HEIGHT & SETBACK LIMITATION DIAGRAM

A 19.00' X 40.27' 765.13 SQ FT

B 18.917' X 8.25' 156.06 SQ FT

PROPOSED EXTENSION:


19.00' X 40.27' 765.13 SQ FT

CELLAR NOT INCLUDED IN FLOOR AREA

19.50 SQ FT

PROPOSED EXTENSION

FLOOR AREA CALCULATIONS

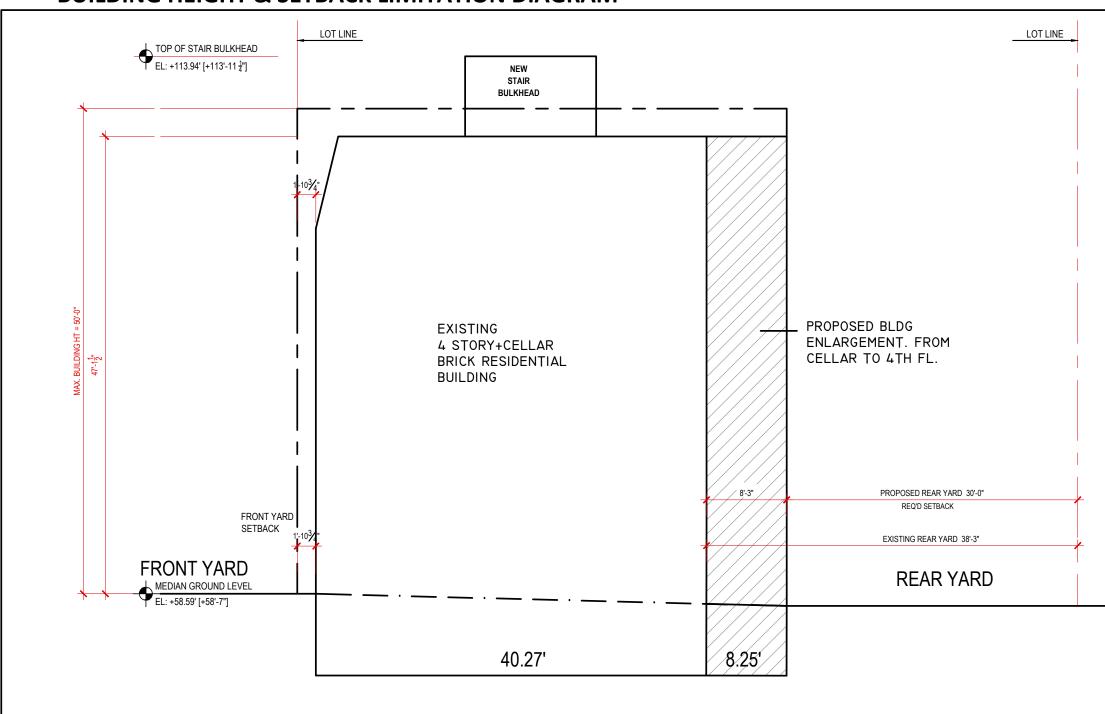

A 19.00' X 40.27' 765.13 SQ FT

18.917' X 8.25' 156.06 SQ FT

2,763.57 SQ FT

TOTAL PER FLOOR 921.19 SQ FT

PER FLOOR X 3 3 X 921.19 SQ FT

PROPOSED EXTENSION:

19.00' X 40.27' 765.13 SQ FT

18.917' X 8.25' 156.06 SQ FT

C 5.00' X 7.00' 35.00 SQ FT TOTAL PER FLOOR 877.19 SQ FT

PROPOSED EXTENSION:

TPPN 10/88 NOTES

TEMPORARY RETAINING SYSTEM.

- 1. THIS PROPERTY IS WITHIN THE BROOKLYN (COBBLE HILL) LANDMARKS HISTORIC DISTRIC. ALL BUILDING WITHIN 90' RADIUS OF THIS PROPERTY ARE ALSO WITHIN THE BOUNDARIES OF THS HISTORIC DISTRICT.
- 2. GC SHALL COMPLY WITH TPPN 10/88 TO AVOID DAMAGE TO HISTORIC LANDMARKS STRUCTURES WITH A 90' RADIUS TO THE
- CONSTRUCTION SITE
- ELECTRO BY CSTABLISHMENT OF A MONITORING PROGRAM 01/2023 LID TILTING OF THE HISTORIC BUILDINGS AND

8.1.1. SETTLEMENTS OF THE STREET AND OF SELECTED POINTS ON THE GROUND ARE TO BE MONITORED.

- 8.2. "TELLTALES" SHALL BE INSTALLED ACROSS EXISTING CRACKS AND IN OTHER SENSITIVE AREAS TO PERMIT CHANGES IN CRACK WIDTH TO BE MEASURED.
- 8.5.1. PHOTOGRAPHS OF SUFFICIENT CLARITY TO VIEW THE "TELLTALES" SHALL BE TAKEN WEEKLY DURING CONSTRUCTION. 8.5.2. PHOTOGRAPHS SHALL BE IDENTIFIED ON THE BACK WITH THE BUILDING ADDRESS, DIRECTION, DATA, TIME, AND PHOTOGRAPHER.
- 9.1. RECORDS OF THE MONITORING PROGRAM SHALL BE RETAINED 9.2. CONTROLLED INSPECTION REPORTS AS TO THE MONITORING PROGRAM SHALL BE SUBMITTED TO THE DEPARTMENT WITHIN 30
- DAYS OF COMPLETION OF THE EXCAVATION. 9.2.1. THE REPORT SHALL INCLUDE A SET OF PHOTOGRAPHS TAKEN PURSUANT TO ITEM 8.5.

BUILDING CODE REFERENCES

ALL WORK SHALL CONFORM TO ALL APPLICABLE GOVERNING CODES INCLUDING BUT NOT LIMITED TO THE FOLLOWINGS.

40 SCHERMERHORN STREET, BROOKLYN, NEW YORK

R6 / C6-2A (LH-1; LIMITED HEIGHT DISTRICT)

RESIDENTIAL -2 FAMILY DWELLING (OLD CODE)

1527.92 SQ. FT. (19.00FT X 80.42FT),

CLASS 3 NON-FIREPROOF (OLD CODE)

270 / 46

NEW YORK CITY BUILDING CODE, 1938 (OLD CODE) NEW YORK CITY MECHANICAL CODE, 2014 NEW YORK CITY ELECTRICAL CODE, 2011 NEW YORK CITY PLUMBING CODE, 2014 NEW YORK CITY FIRE CODE, 2014

ZONING ANALYSIS

LOCATION:

BLOCK / LOT:

LOT AREA:

OCCUPANCY GROUP:

CONST. CLASSIFICATION

ZONING DISTRIC

40 SCHERMERHORN STREET LANDMARKS PRESERES AND COMMISSION

PROJECT :

ELECTRONIC APPROVALION 95401/2023 - LP Brooklyn, NY 11201

PROPERTY OWNER: Ju Young Oh & Michael Kang 40 Schermerhorn Street

Brooklyn, NY 11201 T. 646.915.2399 Contact:

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Juyoung Oh, owner, juyoungoh@gmail.com **ARCHITECT:** KLC ARCHITECTS, PC 180 Maiden Lane, Suite#8A

New York, NY 10038

T. 212.947.0880, Contact: Jay Cho, RA jc@klcapc.com **STRUCTURAL ENGINEER:**

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		ZR SECTION	MAX. PERMITTED	MIN. REQUIRED	EXISTING	PROPOSED	COMPLIANCE	REMARK
USE	USE GROUP (UG)	22-10	UG 1,2,3,4		UG 2	UG 2	ОК	EXISTING 2 FAMILY D.U.
	LOT WIDTH	23-32	-	18'-0"	19'-0"	-	ОК	
LOT	MIN. LOT AREA	23-32	-	1,700 SF	1,527.92 SF	-	ОК	EXISTING LOT
LOT COVERAGE	LOT COVERAGE RATIO	23-153	*63% (adjusted)	-	50.08%	60.07%	ОК	COMPLY
			962.58 SF	-	765.13 SF	921.19	ОК	COMPLY
		12-153 FOR R6	2.2		1.31	1.35	ОК	
FLOOR AREA	F.A.R	34-112; 23-153 FOR C6-2A(R8A EQUIV.)	6.02		2.05	2.99	OK	
RATIO		ADJUSTED(77-22)	3.35 (5,118.52 SF)		3,825.65 SF	4,570.97 SF	ОК	
BUILDING LIMITATIONS	MIN. BASE HT.(R6)	23-662; - 23-691; FOR LH-1	-	30 FT	47.32 FT	-	ОК	EXISTING HT., NO CHANGE
	MIN. BASE HT.(R8A)		-	50 FT (LH-1)	47.32 FT	-	ОК	EXISTING HT., NO CHANGE
	MAX.BASE HT.(R6)		45 FT	-	47.32 FT	-	ОК	EXISTING HT., NO CHANGE
	MAX.BASE HT.(R8A)	34-24(f)	50 FT (LH-1)	-	47.32 FT	-	ОК	EXISTING HT., NO CHANGE
	MAX.BLDG.HT.(R6)		50 FT (LH-1)	-	47.32 FT	-	ОК	EXISTING HT., NO CHANGE
	MAX.BLDG.HT.(R8A)		50 FT (LH-1)	-	47.32 FT	-	ОК	EXISTING HT., NO CHANGE
	FRONT YARD	23-45;23-641;34-231	-	0 FT	1.89 FT	1.89 FT	ОК	NO CHANGE
YARD REQ'S	SIDE YARDS	23-462c;23-632;34-232	-	0 OR 8FT	0 FT	0 FT	OK	NO CHANGE
	REAR YARD	23-47		30'-0"	30'-3"	30'-0"	ОК	NO CHANGE
	DWELLING UNITS	23-22, 35-40	FACTOR (680 SF)	6.70	4	2	OK	2429/1350(=FACTOR)=2
DENSITY	DWELLING UNIT SIZE	23-23	680 SF	325 SF	765.13 SF, DW1 1,530.26 SF, DW2 765.13 SF, DW3 765.13 SF, DW4	921 SF, DW1 3,650 SF, DW2	ОК	
PARKING /	PARKING, PARKING REQ. WAIVER	25-241, 25-26	N.A.	50%(R6), 20%(R8A)	0	0	OK	WAIVED PER 25-26
BIKE REQ'S.	BICYCLES	25-811		1 (1 PER 2 DU)	0	0	ОК	WAIVED LESS THAN 10 DU
TREE	STREET TREE PLANTING	23-03(b)	FLOOR ENLARGEME	NT 20% MORE @ S	PECIAL DOWNTOWN	N BROOKLYN DIST.	ОК	EXISTING, NO CHANGE
PLANTING	SIREET IREE PLANTING	26-41	-	1 (1 PER 25 FT)	1	1	ОК	NO CHANGE
REQ'S	PLANTING STRIP	23-04	-				ОК	

	EXIS	STING	PROPOSED	ENLARGEMENT	TC	TAL	REMARK
CELLAR	784.63	SF	0.00	SF	784.63	SF	NOT COUNTED IN FLOOR AREA CALC.
BASEMENT	765.13	SF	156.06	SF	921.19	SF	
1ST FLOOR	765.13	SF	156.06	SF	921.19	SF	
2ND FLOOR	765.13	SF	156.06	SF	921.19	SF	
3RD FLOOR	765.13	SF	156.06	SF	921.19	SF	
4TH FLOOR	765.13	SF	121.06	SF	886.19	SF	
TOTAL	3,825.65	SF	745.32	SF	4,570.97	SF	

MINIMUM DWELLING SIZE REQUIREMENT:

UNIT1: CELLAR, BASEMENT: 917.76 SQ. FT. > 325 SQ. FT. PER ZR23-23 -**COMPLY** UNIT2: 1ST, 2ND, 3RD, 4TH FLOOR 3,636.04 SQ. FT. > 325 SQ. FT.

NYC ENERGY CONSERVATION CODE COMPLIANCE NOTES:

- 1. THIS IS A HISTORIC BUILDING EXEMPT FROM NYCECC COMPLIANCE RQUIREMENTS AS PER NYCECC §101.4.2.
- 2. 40 SCHERMERHORN STREET IS A CONTRIBUTING BUILDING TO THE BROOKLYN HEIGHTS HISTORIC DISCTRICT, WHIC IS ON THE NATIONAL REGISTER OF HISTORIC PLACES. (NRIS #66000524).

SPECIAL / PROGRESS INSPECTION NOTES INSPECTION ITEMS

- 1. SPECIAL INSPECTIONS SHALL BE CONDUCTED BY QUALIFIED AGENCIES WHO WERE APPROVED AND CERTIFIED BY NYC DOB AND HIRED BY THE OWNER.
- 2. SPECIAL INSPECTOR SHALL KEEP INSPECTION RECORDS FOR 6 YEARS AND SHALL MAKE THE RECORDS AVAILABLE TO THE DOB UPON REQUEST (BC 28-115.3)
- 3. THE CONTRACTOR MUST NOTIFY THE ARCHITECT/ENGINEER OR SPECIAL INSPECTION AGENCY TO COORDINATE THE INSPECTION SCHEDULE PRIOR TO
- 4. SPECIAL INSPECTIONS IS REQUIRED IN ACCORDANCE WITH CHAPTER 17 AND THE APPLICABLE SECTIONS OF THE NYC CONSTRUCTION CODE ARE LISTED IN THE FOLLOWING TABLES:

BC 110.3.1

BC 110.3.4

SPECIAL INSPECTION ITEMS(TR1):

STRUCTURAL STEEL-WELDING	BC 1704.3.1
STRUCTURAL STEEL-DETAILS	BC 1704.3.2
STRUCTURAL HIGH STRENGTH BOLTING	BC 1704.3.3
CONCRETE-CAST-IN -PLACE	BC 1704.27
MASONRY	BC 1704.5
SUBGRADE INSPECTION	BC 1704.7.1
SUBSURFACE INVESTIGATIONS	BC 1704.7.4
MECHANICAL SYSTEM	BC 1704.16
HEATING SYSTEM	BC 1704.25
FIRE-RESISTANT PENETRATIONS AND JOINTS	BC 1704.27
STRUCTURAL STABILITY-EXISTING BUILDINGS	BC 1704.20.1

PROGRESS INSPECTION ITEMS:

FOOTING AND FOUNDATION: FIRE RESISTANCE RATED CONSTRUCTION

FOR ADDITIONAL INFORMATION REFER TO SHEETS

KEY PLAN :	
	SCHERMERHORN ST.
CLINTON ST	OURT ST.
ی ت	STATE ST.

4	4/15/22	LPC FILING REV1
3	2/5/22	LPC FILING
2	2/2/22	OWNER REVIEW
1	12/15/21	OWNER REVIEW
NO:	DATE :	ISSUE:

DOB B-SCAN JOB # STICKER

DOB NOW #B00679292

DOB STAMP




ZONING ANALYSIS, CODE COMPLIANCE

PROJECT No: 210103

DRAWING BY: DK СНК ВҮ : ЈС

SHEET NUMBER : **Z.100.00**

KLCA\210101\DRAWINGS\

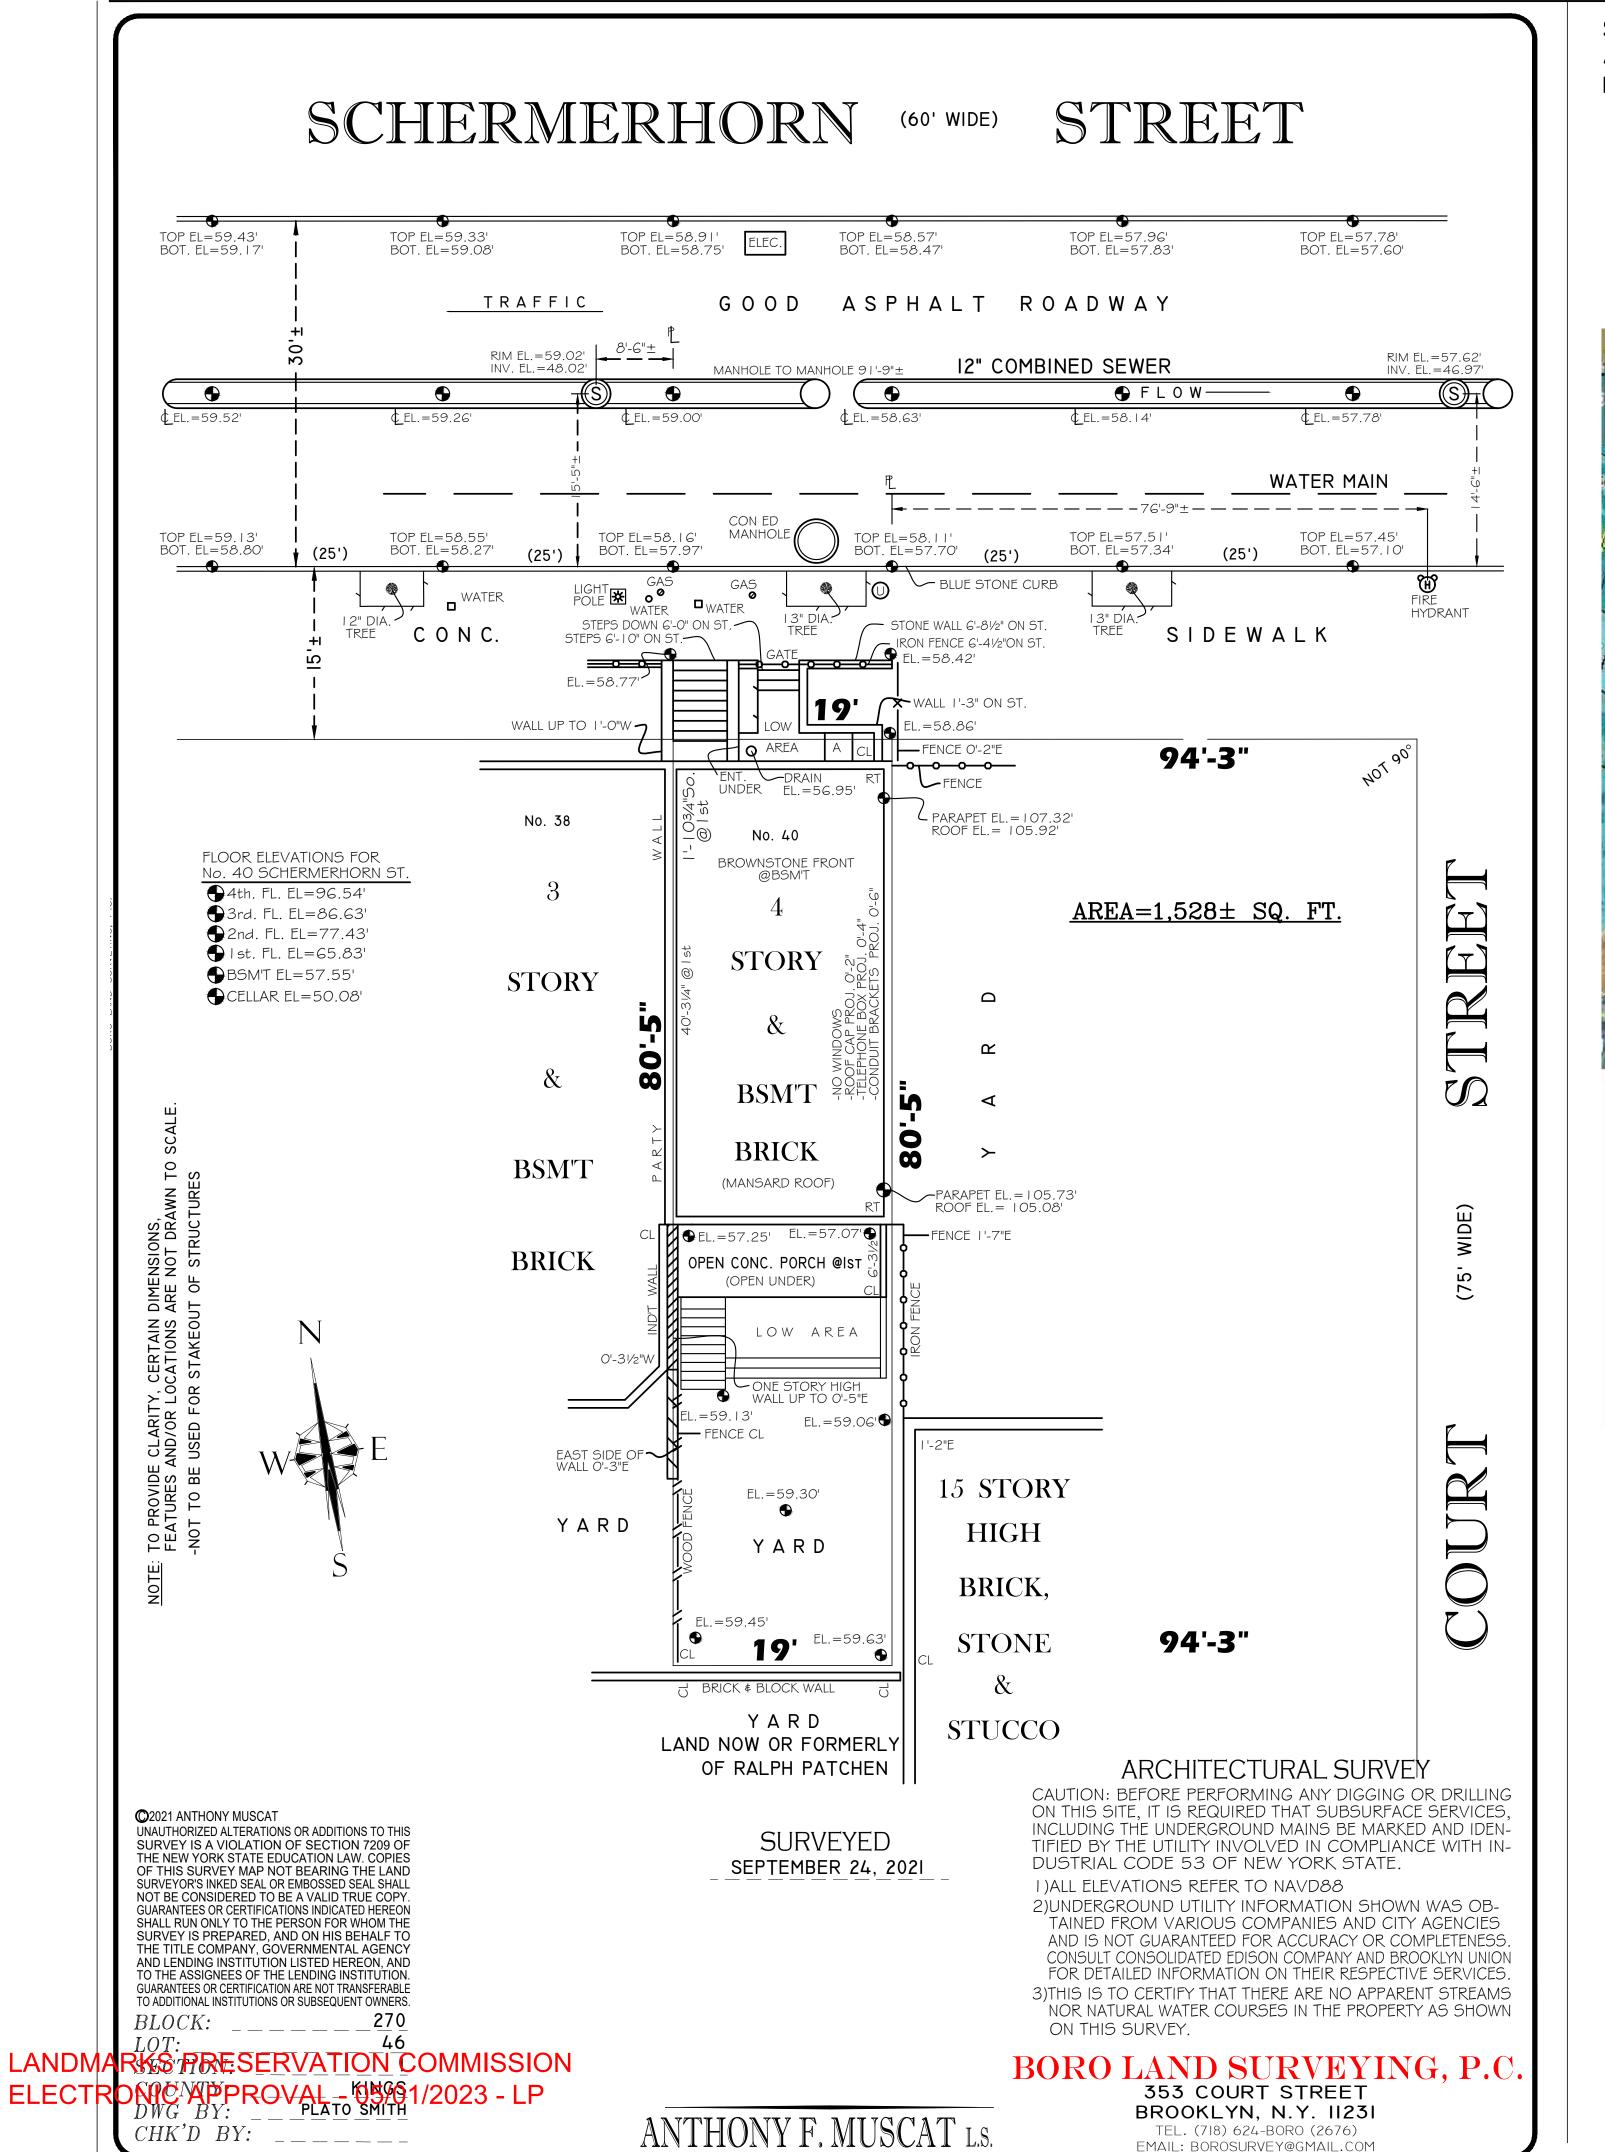

STATEMENT FOR THE COMPLIANCE WITH SPECIAL FLOOD HAZARD AREA REQUIREMENTS MANDATED WITHIN SPECIAL FLOOD HAZARD AREAS: (28-104.9.2, NYC LOCAL LAW 21/09):

LOCAL LAW 21/09: THIS PROPERTY IS NOT LOCATED WITHIN COSTAL ZONES AND WATER-SENSITIVE INLAND ZONES THAT MAY BE AFFECTED BY THE FOLLOWING

TIDAL WETLANDS MAP CHECK:

FRESHWATER WETLANDS MAP CHECK:

COASTAL EROSION HAZARD AREA MAP CHECK:

NO


THIS PROJECT IS NOT FOR FLOOD DAMAGE RECOVERY OR IMPROVEMENT, DO NOT REQUIRE FEMA DESIGN COMPLIANCE, NOR FEMA LOAD CALCULATION.

Otherwise Protected Area

OTHER AREAS Coastal Barrier Resource System Area

FEMA FLOOR MAP

SPECIAL FLOOD HAZARD AREA CHECK:

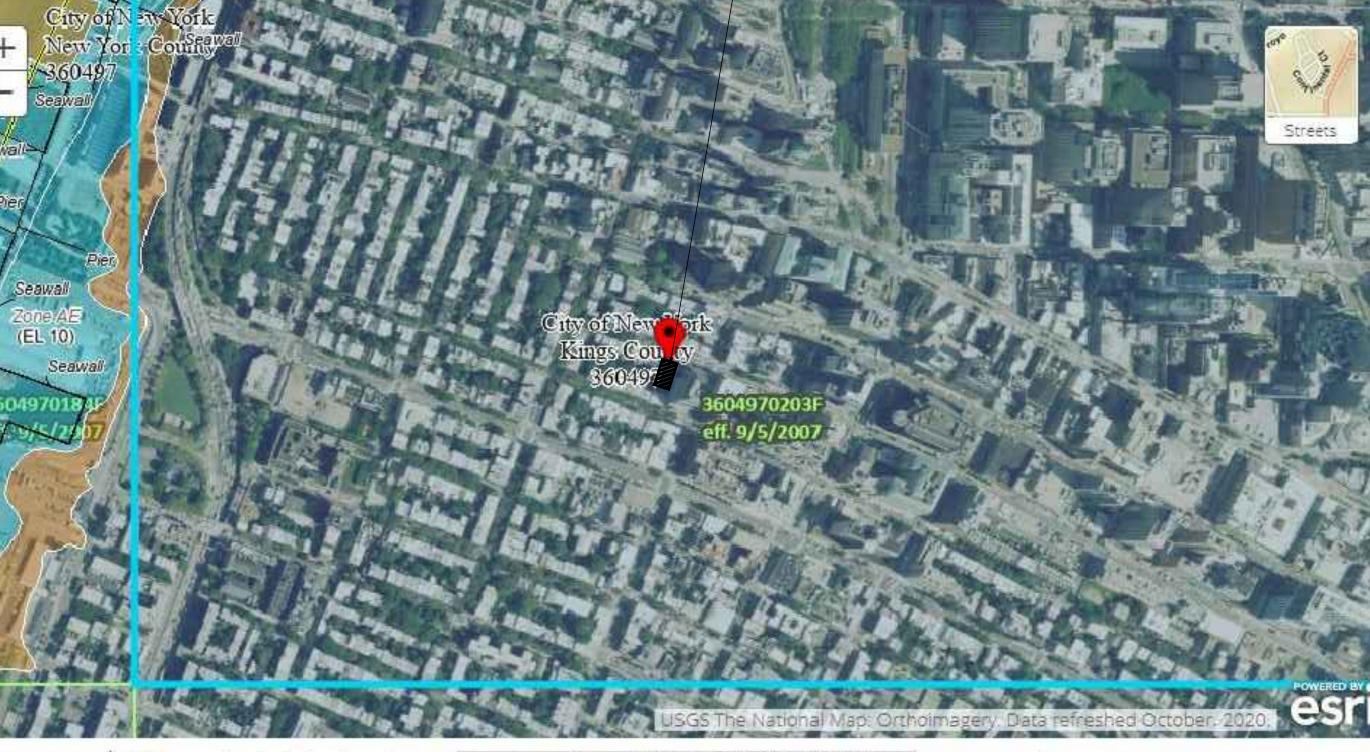

PROPERTY: 40 SCHERMERHORN ST.
IS NOT WITHIN THE FLOOD ZONE

Without Base Flood Elevation (BFE) Approximate location based on user input (E) 20.2 Cross Sections with 1% Annual Chance and does not represent an authoritative 17.5 Water Surface Elevation With BFE or Depth SPECIAL FLOOD property location (i)- - Coastal Transect HAZARD AREAS Regulatory Floodway Zune AE, AO, AH, NE, AR Selected FloodMap Boundary Limit of Study 0.2% Annual Chance Flood Hazard, Areas Jurisdiction Boundary Digital Data Available of 1% annual chance flood with average - Coastal Transect Baseline depth less than one foot or with drainage No Digital Data Available OTHER _ _ Profile Baseline areas of less than one square mile Zone X FEATURES MAP PANELS Hydrographic Feature Future Conditions 1% Annual Chance Flood Hazard Zone X GENERAL --- Channel, Culvert, or Storm Sewer NO SCREEN Area of Minimal Flood Hazard Zone X Area with Reduced Flood Risk due to STRUCTURES | 111111 Levee, Dike, or Floodwall Levee. See Notes. Zone X Effective LOMRs OTHER AREAS OF FLOOD HAZARD Area with Flood Risk due to Levee zone D Area of Undetermined Flood Hazard Zone D

40 SCHERMERHORN STREET LANDMARKS PRESERES PROPRIOR COMMISSION

ANDMARKS PRESERES POENOR COMMISSION ELECTRONIC APPROVALION 05/01/2023 - LP

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SCHERMERHORN ST.

SCHERMERHORN ST.

STATE ST.

4 4/15/22 LPC FILING REV1
3 2/5/22 LPC FILING
2 2/2/22 OWNER REVIEW
1 12/15/21 OWNER REVIEW
NO: DATE: ISSUE:
DOB STAMP

DOB B-SCAN JOB # STICKER
DOB NOW #B00679292

SEAL & SIGNATURE :



CODE COMPLIANCE FEMA, LAND SURVEY

DATE:

PROJECT No: 210103

DRAWING BY: DK

THE BY: JC

SHEET NUMBER: **Z-102.00**

CAD FILE No:

KLCA\210101\DRAWINGS\

PAGE No:

3 of 14









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PROJECT:

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KEY PLAN:

NO: DATE:

DOB B-SCAN JOB # STICKER DOB NOW #B00679292

SEAL & SIGNATURE :

BROOKLYN HEIGHT HISTORIC DISTRICT MAP

LPC.100.00

& STREET VIEW


PROJECT No: 210103


SCHERMERHORN ST.

OWNER REVIEW

STREET

COURT

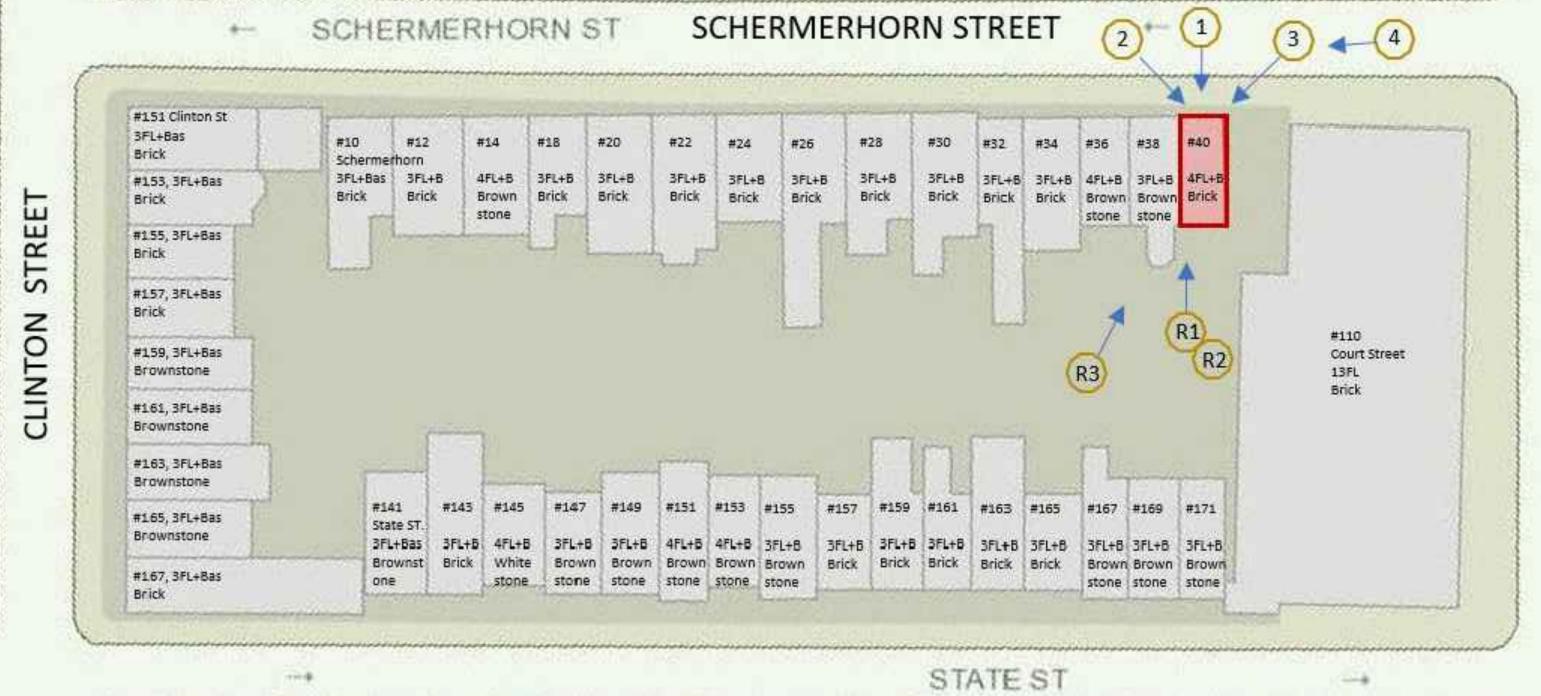

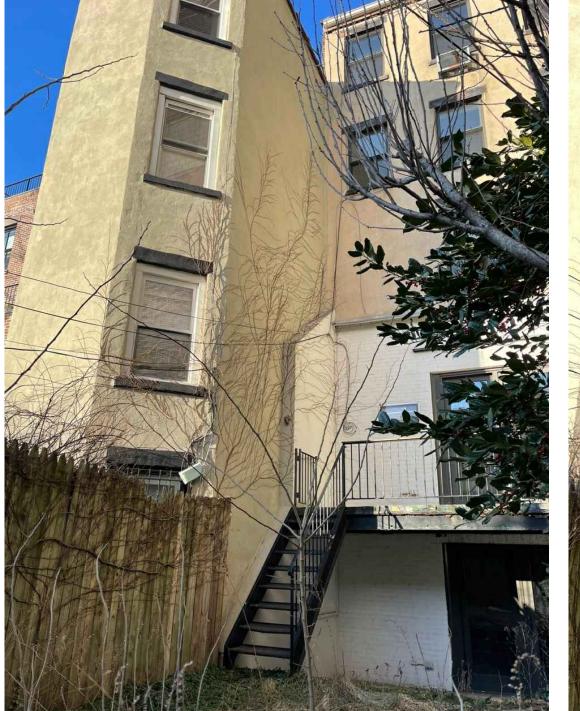



PHOTO#1

PHOTO#R1







PHOTO#R3

PHOTO#R2

ELEVATION NOTES

- ELEVATIONS AND LEGAL GRADES REFER TO THE NORTH AMERICAN VERTICAL DATUM OF 1988 (NAVD 88) WHICH IS 1.44 FEET ABOVE BROOKLYN HEIGHT BOROUGH DATUM.
- 2. PROPERTY SURVEY WAS PERFORMED BY ANTHONY F. MUSCAT, A LICENSED LAND SURVEYOR OF BORO LAND SURVEYING PC. REFER TO Z-101 FOR REPRODUCTION OF THE ORIGINAL SURVEY.
- 3. ALL BUILDING STREET WALL, BASE PLANE, FLOOR AND CEILING ELEVATIONS ARE EXISTING AS SURVEYED.
- 4. THIS PROPERTY IS NOT IN A FLOOD PLAIN.
- 5. DO NOT SCALE THE DRAWINGS. WRITTEN DIMENSIONS SHALL GOVERN. ALL INDICATED DIMENSIONS SHALL BE FIELD VERIFIED. NOTIFY ANY AND/OR ALL DISCREPANCIES TO ARCHITECT PRIOR TO WORK COMMENCEMENT.
- 6. FLOOR LEVELS SHOWN ON ELEVATION ARE BASED ON FINISHED FLOOR. REQUIRE FIELD VERIFICATION.
- 7. FOR ALL NEW WINDOWS & DOORS, SEE WINDOW & DOOR SCHEDULES & NOTES ON A-501.

SCALE: 1/4"= 1'-0"

- 8. INSTALL NEW DECK & RAILING AT REAR YARD AT THE FIRST FLOOR LEVEL PER DETAILS.
- 9. PROVIDE NEW STUCCO LINTELS AND SILLS FOR NEW DOOR & WINDOW OPENING AS PER DOOR & WINDOW SCHEDULE.
- 10. NEW RAILINGS ON ROOF, RAILING AT REAR BALCONY, REAR STAIR AND INTERIOR RAILING AT STAIRWAY & CORRIDOR SHALL BE DESIGNED TO RESIST THE SIMULTANEOUS APPLICATION OF A LATERAL FORCE OF 20 PLF PLUS A VERTICAL LOAD OF 20 PLF, BOTH APPLIED AT THE TOP OF THE RAILING. THE TOTAL LATERAL FORCE AND TOTAL VERTICAL LOAD SHALL BE AT LEAST 200 POUNDS EACH TO COMPLY WITH BC 27-558.



SCALE: 1/4"= 1'-0"


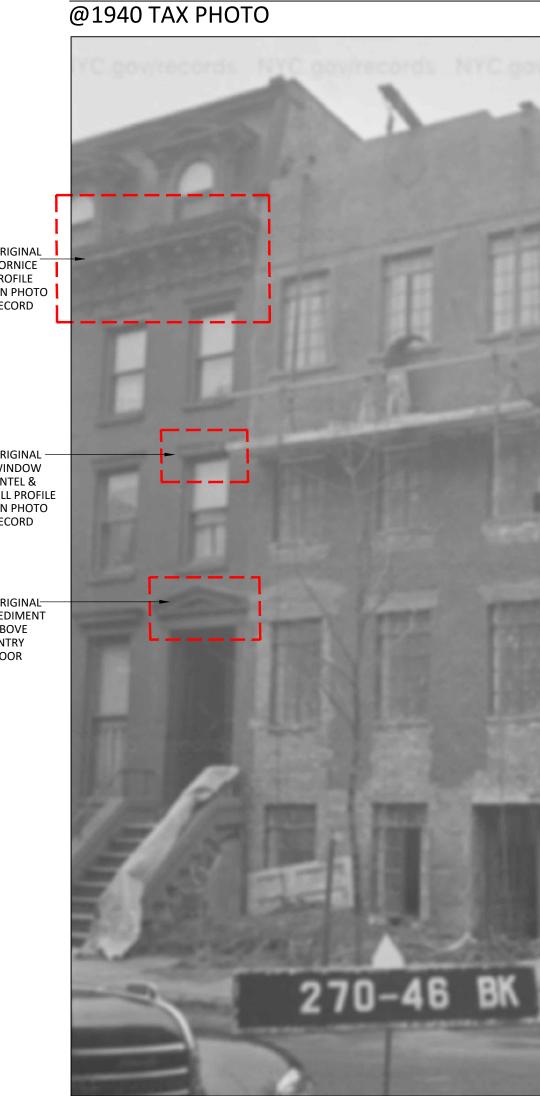


EXHIBIT-2: PROPOSED WALLSCONE @FRONT

STONEHOUSE OUTDOOR ENTRANCE WALL SCONE-SINGLE LIGHT SMOOTH BRONZE COLOR ALUM. FINISH. 8-3/8"W X 13-3/8" H E26 BASE LED



EXHIBIT-1: ORIGINAL CORNICE

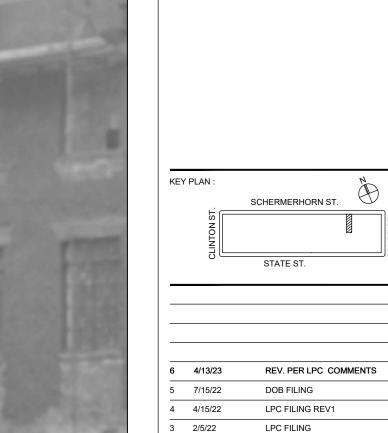

NO: DATE:

DOB STAMP

PROJECT:

LANDMARKS PRESERES AND THOCK COMMISSION

ELECTRONIC APPROVALion 05/01/2023 - LP

Brooklyn, NY 11201

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DOB B-SCAN JOB # STICKER
DOB NOW #B00679292-I1

OWNER REVIEW

OWNER REVIEW

ISSUE:

GSTERED ARCA

SEAL & SIGNATURE :

BUILDING FRONT ELEVATION
& DETAILS

DATE:

PROJECT No: 210103

DRAWING BY: DK

CHK BY: JC

SHEET NUMBER:

A.500.01

CAD FILE No : P KLCA210101\DRAWINGS\

BUILDING FACADE REPAIR NOTES

NEW CORNICE AT BUILDING FRONT FACADE

MOLDINGS TO BE INSTALLED.

1.1. PROVIDE NEW FIBER REINF. POLYMER (FRP) CORNICE, BLACK COLOR PAINTED DIRECTLY ABOVE 3RD FLOOR WINDOWS @ BUILDING FRONT. REFER TO THE PHOTO RECORDS SHOWING THE ORIGINAL CORNICE DESIGN. REPAIR ANY EXISTING DAMAGED / DETERIORATED WALL SURFACES WHERE NEW CORNICE

1.2. RESTORATION CONTRACTOR SHALL PROVIDE FULL FABRICATION **SHOP DRAWINGS FOR** CORNICE FOR LPC REVIEW/APPROVAL

BROWNSTONE/ LIMESTONE REPAIR & RESURFACING

2.1 BROWNSTONE WAS FOUND ON MULTIPLE LOCATIONS ON BUILDING FRONT FACADE INCLUDING WINDOW LINTELS & SILLS, PEDIMENT ABOVE MAIN ENTRY DOORWAY, FRONT STOOP. ALL OF THE ORIGINAL BROWNSTONE LINTELS, SILLS & PEDIMENT WERE OBSERVED SEVERELY MODIFIED AND LOST THEIR ORIGINAL HISTORICAL DESIGN CHARACTER AND PLAN TO REVIVE THEIR HISTORICAL FEATURES TO MATCH CLOSELY TO THE ORIGINAL SHAPE SHOWN ON 1940 TAX PHOTO.

2.2 PROPOSED BROWNSTONE REPAIR, RESURFACE & RESTORE WORK SHALL INCLUDE REMOVAL OF PAINT RESIDUE FROM SURFACE, SURFACE WASHING TO PREPARE TO RECEIVE NEW BROWNSTONE STUCCO COATS AND SURFACE FINISHING.

2.3 SURFACE PREPARATION SHALL INCLUDE TO REMOVE ALL EXISTING LOOSE, DETERIORATED & CRACKED SURFACES DOWN TO THE SOLID SUBSTRATE MATERIAL TO PROVIDE SUFFICIENT BONDING THICKNESS. ANY STRUCTURAL CRACKS SHALL BE REPORTED TO ARCHITECT OR STRUCTURAL ENGINEER AND REPAIRED TO SECURE STABILITY PRIOR TO INSTALL BROWN STONE RESURFACING COAT.

2.4 PROVIDE SURFACE WASHING, SLURRY COAT, SCRATCH COAT & FINISH BROWNSTONE-CEMENT SURFACING COAT IN SEQUENCE TO RESTORE ITS ORIGINAL HISTORIC FEATURE SHAPES.

A. SURFACE WASH:

WASH THE PREPARED SURFACE WITH WATER AND A SOFT BRUSH.

APPLY A THIN SLURRY COAT WITH A BRUSH AND RUB VIGOROUSLY INTO THE SURFACE. THE SLURRY COAT CONSISTS OF MATERIAL IN THE FOLLOWING MIX BY VOLUME:

1 PART WHITE PORTLAND CEMENT 2 PARTS TYPE S LIME

1 PART WHITE PORTLAND CEMENT

6 PARTS SAND MIX WITH WATER

C. SCRATCH COAT:

THE FIRST SCRATCH COAT SHOULD BE PRESSED INTO THE SLURRY COAT WHILE THE SLURRY COAT IS STILL MOIST. EACH SCRATCH SHOULD BE SCORED BEFORE INITIAL DRYING TO PROVIDE A KEY FOR FOLLOWING COATS. NO COAT SHOULD EXCEED 3/8" IN THICKNESS. ABOUT ² HOURS SHOULD BE ALLOWED BETWEEN APPLICATIONS OF SCRATCH COATS. SCRATCH COATS CONSIST OF MATERIAL IN THE FOLLOWING MIX BY VOLUME:

1 PART TYPE S LIME 6 PARTS SAND MIX WITH WATER

THE FINISH COAT IS APPLIED ONCE THE PATCH HAS BEEN BUILT UP TO THE REQUIRED THICKNESS. ONLY THIS LAST COAT IS FORMULATED TO MATCH THE COLOR AND TEXTURE OF THE STONE BEING REPAIRED. THE FINISH COAT SHOULD BE FORMULATED AS FOLLOWS:

1 PART WHITE PORTLAND CEMENT 1 PART TYPE S LIME 2~3 PARTS SAND

3~4 PARTS CRUSHED STONE DRY PIGMENTS

MIX WITH WATER

E. SURFACE FINISHING: SURFACE SHOULD BE FINISHED TO MATCH THE ORIGINAL STONE TOOLING OR EXISTING CONDITION. POSSIBLE TREATMENTS INCLUDE DAMP SPONGING(STIPPLING), DRY TOWELING WITH A WOODEN FLOAT, AND ACID ETCHING WITH DILUTE HYDROFLUORIC ACID, ALL EXECUTED WHILE THE PATCH IS PARTIALLY CURED TO A LEATHER HARNESS.

2.5 REPAIR NOTES:

ALL INGREDIENTS SHOULD BE COMBINED DRY AND THEN MIXED WITH POTABLE WATER. USE DRY PIGMENTS (NATURAL OR SYNTHETIC STABLE OXIDE PIGMENTS) WHEN CRUSHED STONE IS NOT SUFFICIENT TO GIVE A COLOR MATCH, BE CAREFUL NOT TO EXCEED RECOMMENDED MAXIMUM AMOUNTS, AS TOO MUCH PIGMENT REDUCES STRENGTH AND WILL GIVE UNSTABLE COLOR. THE BEST BROWNSTONE PATCHING CONTAINS ACTUAL CRUSHED STONE. USE STONE REMOVED FROM THE AREA BEING REPAIRED OR OLD STONE WITH THE SAME QUALITIES. THE CRUSHED STONE SHOULD BE GROUND AND PASSED THROUGH A 16-MESH SCREEN, AND WASHED THOROUGHLY.

REPAIR. REFINISH OF EXISTING IRON RAILING AT FRONT STOOP. PICKET GATE/FENCE. IRON SECURITY WINDOW BARS AT BASEMENT LEVEL:

3.1 CONTRACTOR SHALL INSPECT THE CONDITION OF RAILING CONNECTIONS AND MOUNTING ETC. THOROUGHLY.

3.2 SCRAPING OFF THE LOOSE/PEELED PAINT:

A. TEST A PATCH OF THE IRON RAILING FOR LEAD. IF TEST TURNS OUT POSITIVE, REMOVAL OF LEAD PAINT SHALL BE PERFORMED BY CERTIFIED PAINTING CONTRACTOR.

B. USE A FLAT METAL BLADE TO SCRAPE OFF LARGE FLAKES OF OLD PAINT.

C. RUB A WIRE BRUSH OVER THE CURVED PORTIONS OF THE RAILING AND SCRAPE BACK AND FORCE OVER THE METAL SURFACE.

D. SAND ENTIRE SURFACE TO REMOVE LINGERING PAINT. E. USE CHEMICAL PAINT STRIPPER ON STUBBORN PAINT.

3.3 PROTECTING AND REPAINTING:

A. WIPE OFF THE RAILING WITH A TACK CLOTH OR MINERAL SPIRITS

B. APPLY METAL PRIMER, APPLY 1 OR 2 COAT(S) OF OIL BASE BLACK COLOR PAINT.

BRICK PATCHING

PARTS OF THE ORIGINAL BRICKS ON BUILDING FRONT HAD BEEN REMOVED/CUT TO PROVIDE WALL SLEEVES FOR INSTALLATION OF AIR CONDITIONING UNITS. PROPOSED BRICK PATCHING WORK SHALL INCLUDE REMOVAL OF AC UNIT SLEEVES, INSTALLATION OF NEW MASONRY SUBSTRATE TO CLOSE SLEEVES INTERIOR SIDE, INSTALLATION OF NEW RED BRICK THAT WILL MATCH TO ITS ORIGINAL COLOR, SIZE & SURFACE TEXTURE.

4.2 REMOVAL & OPENING CLOSE:

REMOVE ALL DAMAGED CUT BRICKS AND EXCESSIVE MORTAR PATCHING SURROUND OF THIS AC SLEEVES, ALL NEW BRICK INFILL SHALL BE TOOTHED TO ACHIEVE ITS ORIGINAL BRICK FACADE MONOLITHIC LOOK.

4.3 MORTAR MIX & GROUT COLOR/TYPE MATCH:

INSTALL NEW SELECTED BRICKS WITHIN INFILL AREAS, USE MORTAR MIX AS PER SECTION #5.6 ~#5.10 BELOW.

4.4 CONTRACTOR SHALL RESOURCE THE MATCHING BRICK INCLUDING CUSTOM BRICK MANUFACTUERER. PRESENT BRICK SAMPLE OR MOCK UP SAMPLE TO THE OWNER/ARCHITECT/LPC STAFF FOR APPROVAL PRIOR TO PURCHASE, ALL BRICK INSTALLATION SHALL COMPLY WITH MANUFACTURER'S INSTALLATION MANUAL, PERFORM NEW BRICK WORK WHEN THE TEMPERATURE AT A CONSTANT 45°F OR ABOVE FOR A 72-HOUR PERIOD FROM THE COMMENCEMENT OF THE WORK.

BRICK RE-POINTING

5.1 PRE-INSPECTION: CONTRACTOR SHALL THOROUGHLY INSPECT THE CONDITION OF EXISTING BRICK JOINTS AT FRONT FACADE AND DETERMINE THE RE-POINTING REQUIRED

5.2 PROVE TO FIND THE ORIGINAL MORTAR COLOR, TEXTURE AND HARDNESS TO MATCH IF POSSIBLE.

5.3 REMOVE ALL CRACKED, DETERIORATED AND/OR INAPPROPRIATELY APPLIED MORTAR FROM THE BRICK JOINTS BY HAND USING A CHISEL. NOT USING ELECTRIC SAWS. CARE SHOULD BE TAKEN NOT TO CHIP THE EDGES OF THE BRICKS. NO OVER-CUTTING OR WIDENING OF MORTAR JOINTS.

5.4 CLEAN THE EXISTING MORTAR IF IT IS DIRTY TO ACHIEVE A CLOSE MATCH.

5.5 IF A PREVIOUS RE-POINTING WORK INVOLVED THE USE OF THE WRONG COLOR OR PROFILE, REMOVE THIS INAPPROPRIATE MORTAR SECTIONS AND REPLACE IT WITH CORRECT COLOR UNLESS IT CONTAINS A HIGH CEMENT CONTENT WHICH IS VERY HARD AND DIFFICULT TO REMOVE IT WITHOUT DAMAGING THE SURROUNDING BRICK.

5.6 MORTAR MIX:

SOFT MORTAR WAS MOST COMMONLY USED TO RE-POINT MOST OF 19TH CENTURY HISTORICAL BUILDINGS. AND ITS MORTAR MIX SHOULD BE:

1 PART WHITE PORTLAND CEMENT (ASTM C 150) 2-1/2 PARTS LIME 5-6 PARTS SAND PARTS ARE BY VOLUME

-MIX DRY INGREDIENTS FIRST BEFORE ADDING PORTABLE WATER

-USE DRY PIGMENTS (NATURAL OR SYNTHETIC STABLE OXIDE PIGMENTS) TO TINT OR COLOR MORTAR AND MIX ALL INGREDIENTS THOROUGHLY.

5.7 BRICK JOINTS MUST BE WET BEFORE RE-POINTING THE MORTAR PRESSED WELL BACK INTO THE JOINTS.

5.8 BRICK JOINTS SHALL MATCH TO THE ORIGINAL "FLUSH TYPE".

5.9 IN CASE IF THE BRICK IS CRACKED, CONSIDER TO USE A REPAIR GROUT OR EPOXY TO RESTORE TO THE ORIGINAL APPEARANCE.

5.10 RECONSTRUCTION OF MORTAR JOINTS SHALL BE PERFORMED ONLY WHEN THE TEMPERATURE REMAINS AT A CONSTANT 45 DEGREES IN FAHRENHEIT OR ABOVE FOR A 72-HOUR PERIOD FROM THE COMMENCEMENT OF THE WORK.

6. STUCCO

6.1 EXISTING STUCCO REFINISH AT SIDE WALL

-NO VISUAL DAMAGE OR CRACKS ON STUCCO SURFACES WERE OBSERVED EXCEPT FOR MINOR COLOR STAIN MARKS BELOW THE COPING STONE AT ROOF PARAPET LEVEL AND AREA OUTSIDE CHIMNEY WALL. THIS STAIN SEEMS CAUSED BY IMPROPER INSTALLATION OF COPING STONE WHICH ALLOW RAIN INFILTRATION INTO THE STONE JOINTS OR RAIN OVERRUN.

-REFINISH WORKSCOPE SHALL BE LIMITED TO STAIN REMOVAL/CLEANING / TOUCH UP STUCCO COAT OVER EXISTING SURFACE WITH THE LPC/OWNER SPECIFIED COLOR.

6.2 NEW STUCCO ON REAR FACADE (NEW EXTENSION AREA) & STAIR BULKHEAD:

-PROVIDE NEW CEMENTITIOUS STUCCO WITH THE OWNER/LPC SPECIFIED COLOR AT REAR BUILDING EXTENSION WALL AREA. ATTACH 18GA WIREMESH OR METAL LATH TO NEW CMU WALL WITH POWDER ACTUATED FASTENERS OR HARDENED CONCRETE STUB NAILS 16"O.C. MAX. HORIZONTALLY, 7"O.C. MAX. VERTICALLY. PROVIDE A CORNER BEAD AROUND WINDOW OPENING. REFER TO WALL SECTION DETAIL.

6.3 APPROVED STUCCO COAT PRODUCT: MASTERPROTECT HB200 (THOROCOAT 200) PROPOSED STUCCO COLORS ARE

#9229 GRAY :OUTLAW @STAIR BULKHEAD #9247 BROWN: COBBLESTONE PATH

REPAIR, REFINISH OF EXISTING ENTRY DOOR


7.1 EXISTING MAIN ENTRY DOOR AT FIRST FLOOR AND ITS WOODEN SURROUNDING PANEL MOLDINGS APPEARS TO BE PART OF ORIGINAL HISTORIC DECORATIVE FEATURE SHALL BE REPAIRED AND REFINISHED FOR REUSE. WORKSCOPE SHALL INCLUDE REPAIR OR REPLACE OF DOOR HARDWARE.

7.2 STRIPPING OFF PAINT LAYERS FROM DOOR/MOLDING SURFACES, SANDING, PATCHING ON ALL CHIPPED AREA AND STAINING AS PER COLOR/FINISH SPECIFICATION SELECTED BY OWNER/LPC.

WINDOWS

SEE WINDOW & DOOR SCHEDULES & NOTES ON A502.

9.1 GENERAL REQUIREMENTS RAILINGS AND PARAPETS AROUND STAIRWELLS, BALCONIES, AREAWAYS, AND ROOFS, AND OTHER RAILINGS IN SIMILAR LOCATIONS FOR THIS TWO FAMILY DWELLINGS SHALL BE DESIGNED TO RESIST THE SIMULTANEOUS APPLICATION OF A LATERAL FORCE OF 20 PLF PLUS A VERTICAL LOAD OF 20 PLF, BOTH APPLIED AT THE TOP OF THE RAILING. THE TOTAL LATERAL FORCE AND TOTAL VERTICAL LOAD SHALL BE AT LEAST 200 POUNDS EACH TO COMPLY WITH

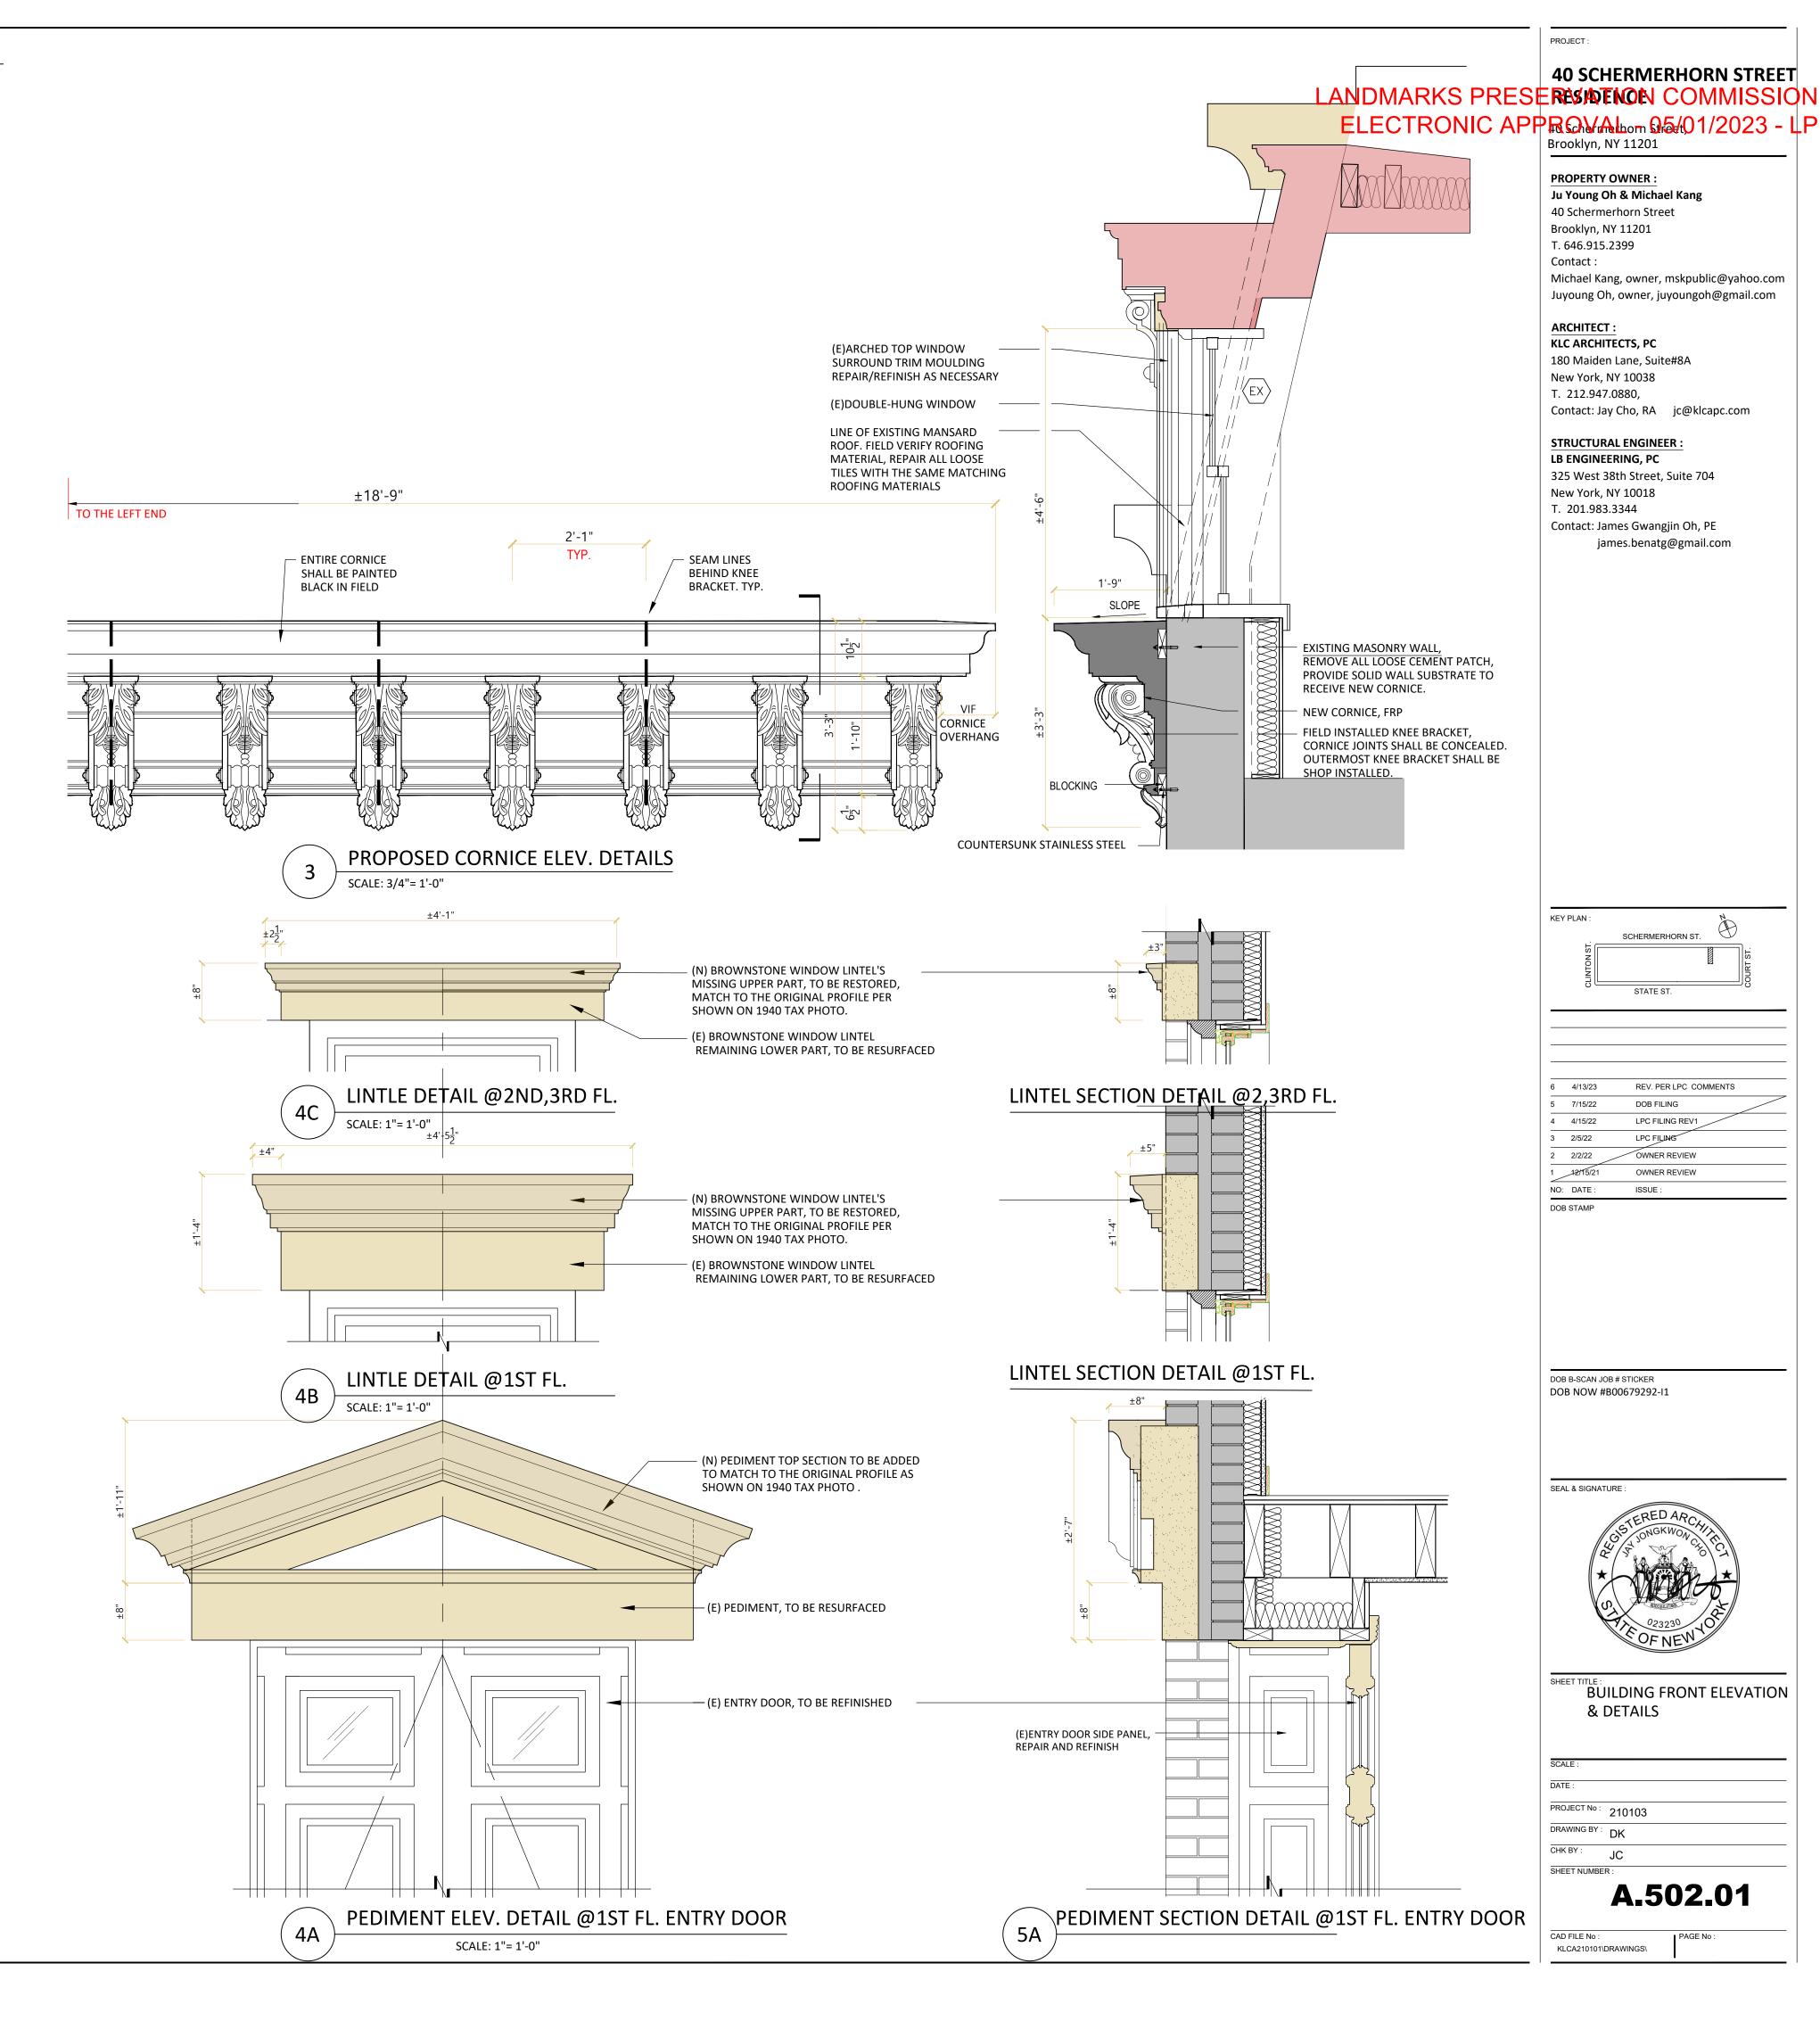

james.benatg@gmail.com

SCHERMERHORN ST.

REV. PER LPC COMMENTS

BUILDING FRONT ELEVATION

A.502.01

& DETAILS

LPC FILING REV

OWNER REVIEW

OWNER REVIEW

LPC FILING

ISSUE:

LANDMARKS PRESERVATION COMMISSION ELECTRONIC APPROVAL - 05/01/2023 - LP

